



Typical Attenuation Tank Floor Plan

Scale : 1:50

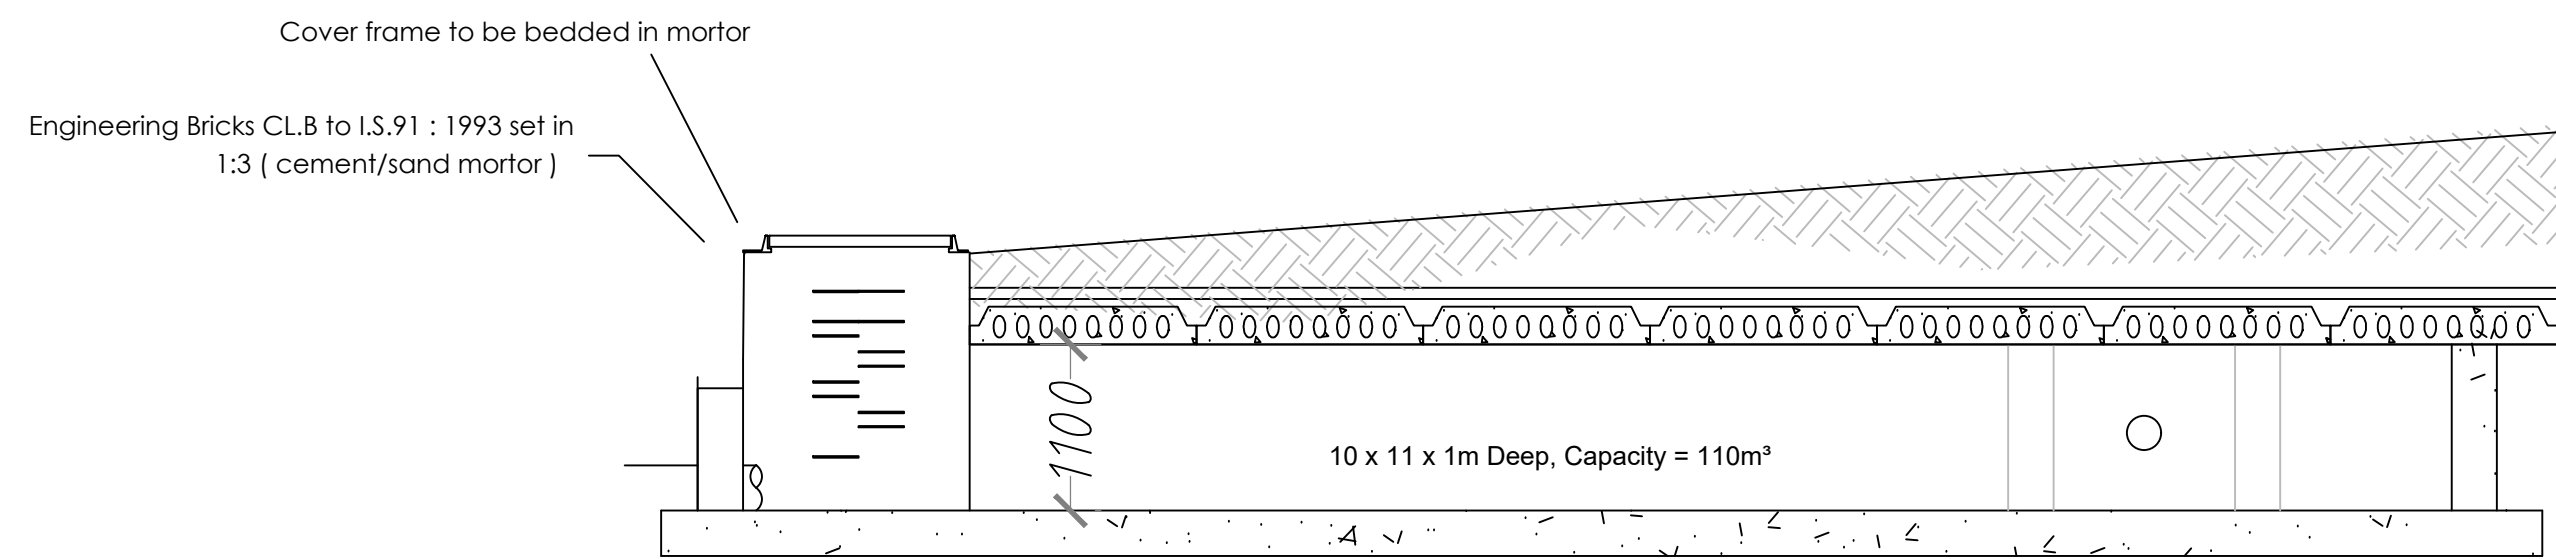

Section A-A

Scale : 1:50

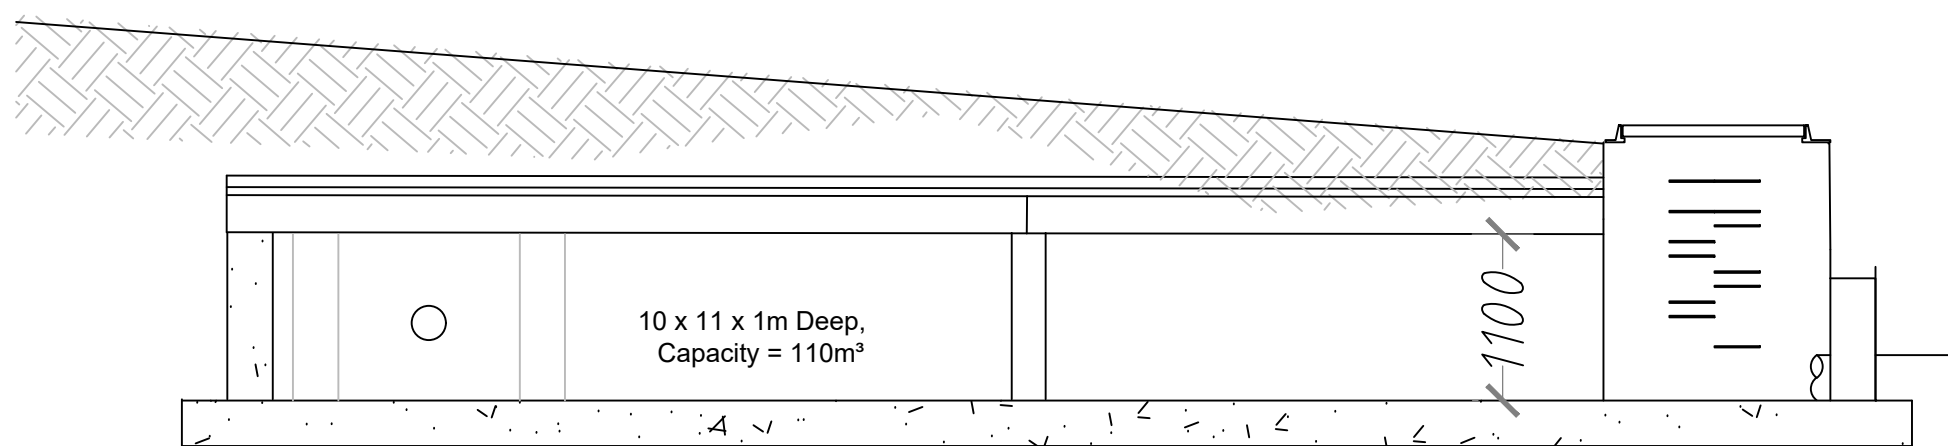

Section B-B

Scale : 1:50

**Notes:**  
1. This drawing is for the purpose of the stage indicated only. - If in doubt ask.  
2. Do not scale. Figured dimensions only to be taken.  
3. Engineer/Architect to be informed of any discrepancies before work proceeds.  
4. Contractor to check all dimensions and conditions on site before commencing works.  
5. Drawing to be read in conjunction with current Building Regulations.  
6. All components and materials to be installed fully in accordance with manufacturers instructions.

Rev	Date	Description	Drawn	Chk'd
A	09-10-2023	ISSUED FOR PLANNING APPLICATION	JB	BOK/GF

**BRIAN O'KENNEDY & ASSOCIATES LTD**  
Engineers-Architects

Shannon House,  
Charney Road,  
Douglas,  
Co Cork

Tel: 021-4899854  
Fax: 021-4899854  
Email: info@bok.ie  
Web: www.bok.ie

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GENERAL NOTE:  
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Drawing Status:	
LRD - PLANNING APPLICATION	
Client: CASTLE ROCK HOMES (MIDLETON) LTD	
Project: RESIDENTIAL DEVEL. AT BROOMFIELD, MIDLETON	
Drawing: PROPOSED STORM ATTENUATION TANK SECTIONS & DETAILS	Date: 09/05/2023 Scale: 1:50 @ A1
Drawing number:	Rev: Drawn Chk'd:
22/6732-P-1323	A G.F. BOK

CastleRock Homes